## AREA TOTALS

Name

Area

* SECONDARY DWELLING	60 m²
* VERANDAH	25 m²
* CARPORT	22 m²
	100 0

106 m²

NOTES:

- PORTAL STEEL FRAME WITH TIMBER STUD FRAME EXTERNAL WALL

- CONCRETE SLAB ON GROUND

- ALL CONSTRUCTION TO BE IN ACCORDANCE WITH RELEVANT AUSTRALIAN

STANDARDS AND NCC 2022 VOLUME 2 AND ABCB HOUSING PROVISIONS.


- WET AREAS ARE TO BE CONSTRUCTED AND WETSEALED IN ACCORDANCE TO ABCB HOUSING PROVISIONS PART 10.2


- ALL GLAZING TO BE IN ACCORDANCE WITH ABCB HOUSING PROVISIONS PART 8

- COLORBOND ROOFING AND STEEL CLADDING TO BE IN ACCORDANCE WITH CHOSEN

PRODUCT SPECIFICATIONS AND RELEVANT AUSTRALIAN STANDARDS.

- ENERGY EFFICIENCY TO MEET BASIX REQUIREMENTS AT A MINIMUM.

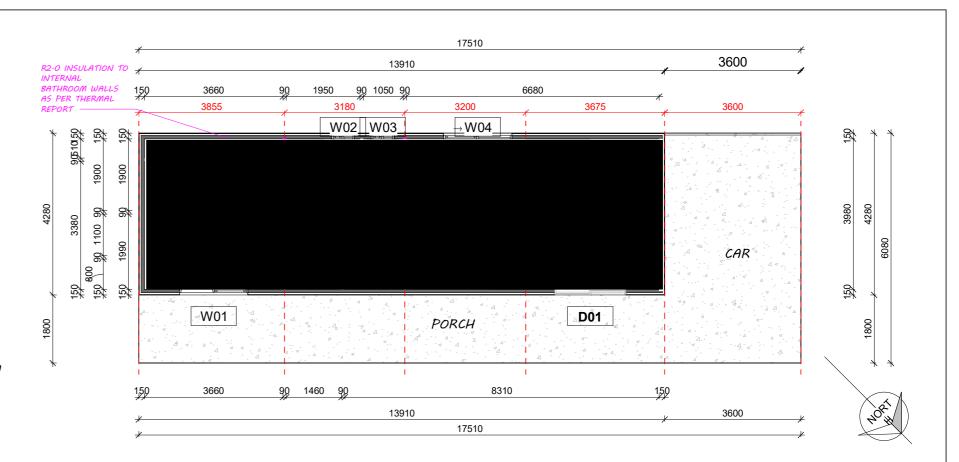

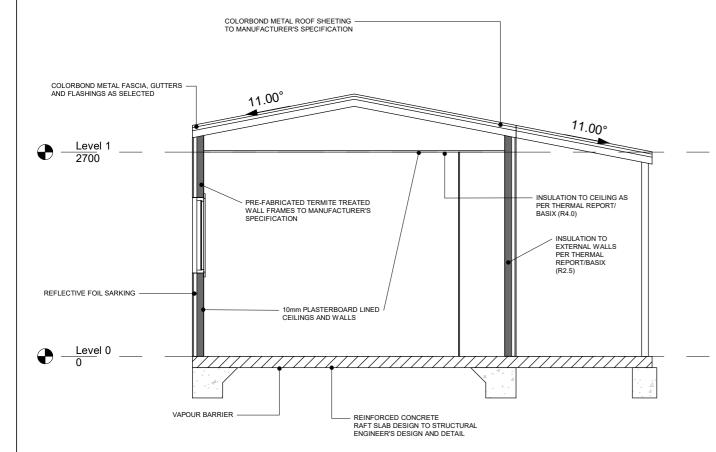


				WINDOW SCHEDULE		
Mark	Type	Height	Width	Comments	Eaves	Areas

						6·18 m²
W04	1018	1000	1810	ALUMINIUM FRAMED - DOUBLE GLAZED - SLIDING	0	1.81 m²
<del>₩03</del> -	0906	910	610	ALUMINIUM FRAMED - DOUBLE GLAZED - SLIDING	0	0.56 m²
W02	0906	910	610	ALUMINIUM FRAMED - DOUBLE GLAZED - SLIDING	0	0.56 m²
W01	1818	1800	1810	ALUMINIUM FRAMED - DOUBLE GLAZED - SLIDING	1800	3·26 m²

			DOOR SCHEDULE		
Mark	Height	Width	Comments	Eaves	Area
D01	2110	1810	ALUMINIUM FRAMED - SLIDING DOOR - DOUBLE GLAZED/LOW-E	1800	3.82 m²
	1				3.82 m²

No.	Description	Date	BENT SECONDARY DWELLING	FLOOR	PLAN &	SECTION	
				Project number	Project Number		
			5 DE SALIS DR, JUNEE	Date	Issue Date	S02.1	
				Drawn by	Author		
				Checked by	Checker	Scale	As indicated
	No.	No. Description	No. Description Date		Image: Second arrow of the se	Image: Constraint of the second se	Image: stand stan

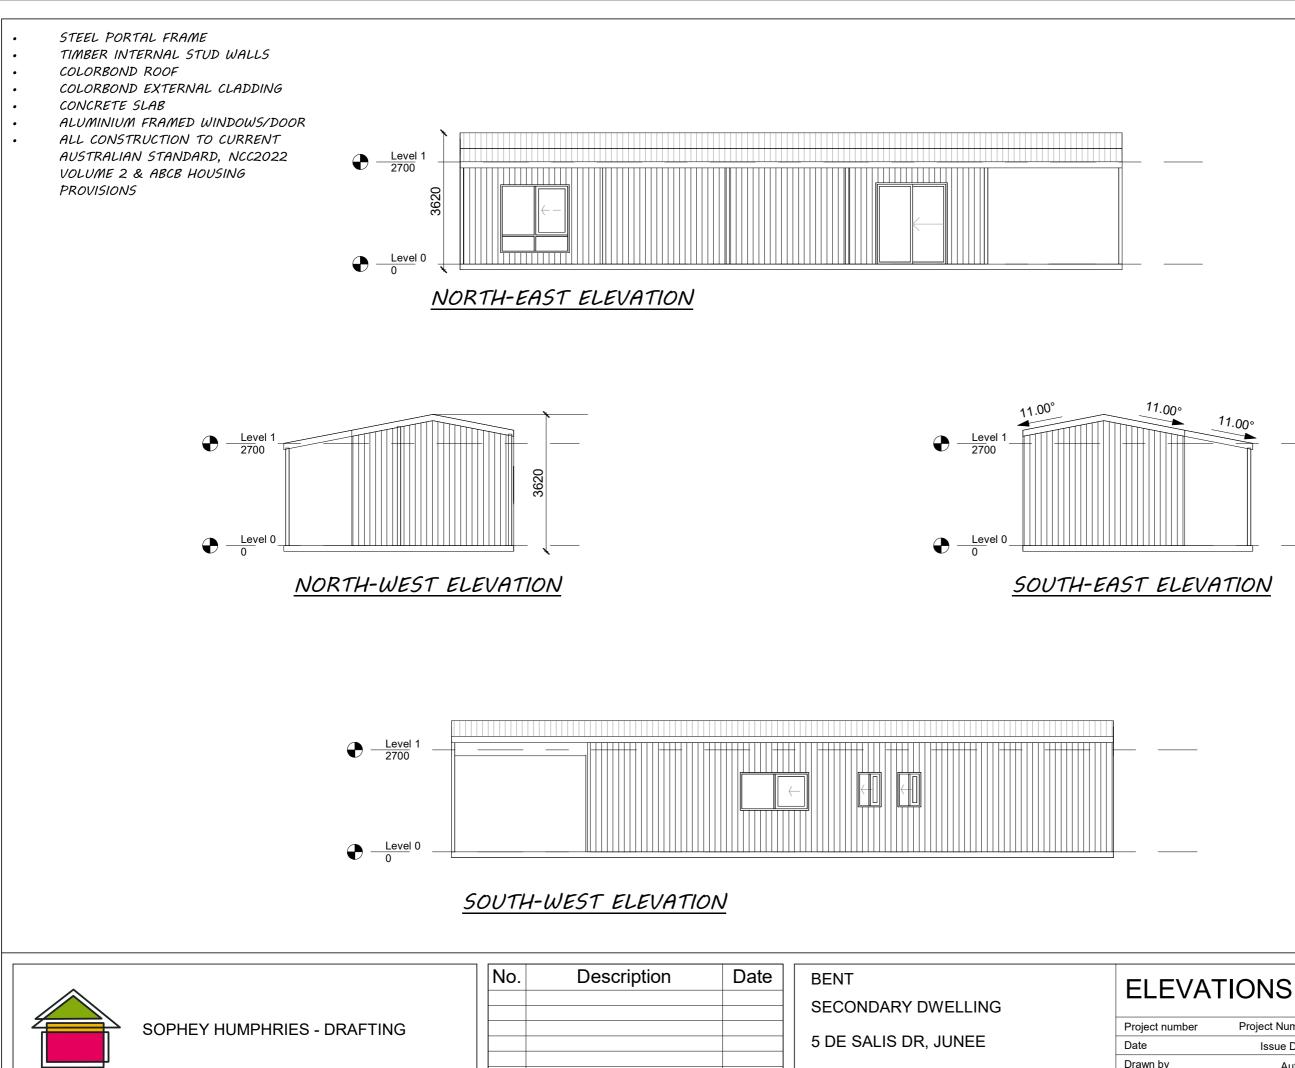

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Checked by

## ATIONS ber Project Number Issue Date Author Checker Scale 1:100

19/03/2024 1:22:59 PM

## BASI Certificate

Building Sustainability Index www.basix.nsw.gov.au	Project name	De Salis 5 2663	
Cinela Dualling	Street address	5 DE SALIS Drive JUNEE 2663	
Single Dwelling	Local Government Area	Junee Shire Council	
Certificate number: 1740222S	Plan type and plan number	Deposited Plan DP811541	
	Lot no.	23	
	Section no.	-	
This certificate confirms that the proposed development will meet the NSW	Project type	dwelling house (detached) - seconda	ary dwelling
government's requirements for sustainability, if it is built in accordance with the commitments set out below. Terms used in this certificate, or in the commitments.	No. of bedrooms	1	
have the meaning given by the document entitled "BASIX Definitions" dated 10/09/2020 published by the Department. This document is available at	Project score		
www.basix.nsw.gov.au	Water	✓ 20	Target 20
Secretary Date of Issue: Monday, 18 March 2024	Thermal Performance	✓ Pass	Target Pas
To be valid, this certificate must be lodged within 3 months of the date of issue.	Energy	✓ 17	Target 64
	Materials	✓ 25	Target n/a
NSW			

Project s

Certificate Prepared by	
Name / Company Name: Energyraters	

Thermal Performance and Materials commitments	Show on DA plans	Show on CC/CDC plans & specs	Certifier
Simulation Method			
Assessor details and thermal loads			
The applicant must attach the carificate referred to under "Assessor Details" on the front page of this BASIX carificate (the "Assessor Carificate") to the evelopment application and construction carificate application for the proposed development (c, if the applicant is applying for a complying development carificate for the proposed development, to that application). The applicant must also attach the Assessor Certificate to the application for an occupation carificate for the proposed development.			
The Assessor Certificate must have been issued by an Accredited Assessor in accordance with the Thermal Comfort Protocol.			
The datals of the proposed development on the Assessor Certificate must be consistent with the datals shown in this BASIX certificate, including the Cooling and Heating loads shown on the front page of this certificate and the "Construction" and "Giazing" tables below.			
The application must show on the plane accompanying the development application for the proposed development, all matters which the Assessor Coefficient requires to be shown on those plans. Those plans must bear a stamp of endorsement from the Accredited Assessor to certify this is the cass. The applicant must show the plans accompanying the application for accredited certificate (or complying development certificate), if application the plans accompanying the application to the Assessor Certificate, and all applicate of the proposed development that there used to calculate three specifications are set out. In the Assessor Certificate, and all application of the proposed development that there used to calculate three specifications.	~	~	*
The applicant must construct the development in accordance with all thermal performance specifications set out in the Assessor Cartificate, and in accordance with those aspects of the development application or application for a complying development certificate which were used to calculate these specifications.		~	~
The applicant must show on the plans accompanying the development application for the proposed development, the locations of celling fans set cut in the Assessor Certificate. The applicant must show on the plans accompanying the applicable for a construction certificate (or compying development certificate), regiscrable, the locations of celling fans set out in the Assessor Certificate.	~	~	~
			<u> </u>
			<u> </u>
Note			
Note			
Note			

Energy Commitments	Show on DA plans	Show on CC/CDC plans & specs	Certifier check
Hot water			
The applicant must install the following hot water system in the development, or a system with a higher energy rating: electric instantaneous.	~	~	~
Cooling system			
The applicant must install the following cooling system, or a system with a higher energy rating, in at least 1 living area: 1-phase airconditioning - ducted; Energy rating: 4 star (cold zone)		~	~
The applicant must install the following cooling system, or a system with a higher energy rating, in at least 1 bedroom: 1-phase airconditioning - ducted; Energy rating: 4 star (cold zone)		~	~
Heating system			
The applicant must install the following heating system, or a system with a higher energy rating, in at least 1 living area: 1-phase airconditioning - ducted; Energy rating: 4 star (cold zone)		~	~
The applicant must install the following heating system, or a system with a higher energy rating, in at least 1 bedroom: 1-phase airconditioning - ducted; Energy rating: 4 star (cold zone)		~	~
Ventilation			
The applicant must install the following exhaust systems in the development:			
At least 1 Bathroom: individual fan, open to façade; Operation control: manual switch on/off		~	~
Kitchen: individual fan, ducted to façade or roof; Operation control: manual switch on/off		~	~
Laundry: individual fan, ducted to façade or roof; Operation control: manual switch on/off		~	~
Artificial lighting			
The applicant must ensure that a minimum of 80% of light fixtures are fitted with fluorescent, compact fluorescent, or light-emitting- clode (LED) lamps.		~	~
Natural lighting			
The applicant must install a window and/or skylight in the kitchen of the dwelling for natural lighting.			

Energy Commitments	Show on DA plans	Show on CC/CDC plans & specs	Cer
The applicant must install a window and/or skylight in 2 bathroom(s)/toilet(s) in the development for natural lighting.	~	~	
Alternative energy			
The applicant must install a photovoltaic system as part of the development. The applicant must connect this system to the development's electrical system.	~	~	
The photovolatic system must consist of:			
<ul> <li>photovolatic collectors with the capacity to generate at least 1 peak kilowatts of electricity, installed at an angle between 10 degrees and 25 degrees to the horizontal facing north</li> </ul>	~	~	
Other			
The applicant must install a fixed outdoor clothes drying line as part of the development.		~	Г
L			_



Glazing	
The application of the listed in the	ant must install windows, glazed doors and sk e table.
<u> </u>	
I	
Frames	
Frames	_
aluminium	
aluminium timber	
aluminium timber uPVC	
aluminium timber uPVC steel	
aluminium timber uPVC steel	
aluminium timber uPVC steel composite	

Legend					
In these commitments	"applicant" means the person of	arrying out the development.			
Commitments identifie development applicat	d with a 💙 in the "Show on DA on is to be lodged for the propor	plans* column must be shown or sed development).	the plans accompanying the o	levelopment application for the	e propos
Commitments identifie certificate / complying	d with a 💙 in the "Show on CC development certificate for the p	/CDC plans and specs" column n proposed development.	nust be shown in the plans and	specifications accompanying	the app
Commitments identifie final) for the developm	d with a 💙 in the "Certifier chec ent may be issued.	ck" column must be certified by a	certifying authority as having b	een fulfilled, before a final occ	upation

	No.	Description	
SOPHEY HUMPHRIES - DRAFTING			
			-

Date	BENT
	SECONDARY DWELLING
	5 DE SALIS DR, JUNEE

BAS
Project num
Date
Drawn by

Drawn by Checked by

Description of project

Project address		Assessor details and then	mal loads	
Project name	De Salis 5 2863	Assessor number	DMN/15/1694	
Street address	5 DE SALIS Drive JUNEE 2003	Certificate number	0009313610	
ocal Government Area	Junee Shire Council	Climate zone	20	
Plan type and plan number	Deposited Plan DP811541	Area adjusted cooling load (MJ/	20	
ot no.	23	m².year)	76	
ection no.		Area adjusted heating load (MJ/ m <sup>2</sup> .year)	76	
roject type		Project score		
oject type	dwelling house (detached) - secondary dwelling	Water	20	Target 20
of bedrooms	1		V 20	Target 20
ite details		Thermal Performance	V Pass	Target Par
te area (m²)	9191	Energy		Tarpet 64
cof area (m²)	107	Cheigy	¥ 77	Target 64
onditioned floor area (m <sup>2</sup> )	48.7	Materials	25	Target n/a
Inconditioned floor area (m <sup>2</sup> )	5.9			
Total area of garden and lawn (m²)	100			
Roof area of the existing dwelling (m <sup>2</sup> )	400			
	4			

Construction		_	DA plans	plans & specs	check
	and glazing of the dwelling in accordance with the specifications	listed in	~	~	~
The applicant must show through receipts that the materials p the tables below.	urchased for construction are consistent with the specifications	isted in			~
		_			
Construction	Area - m²	Insulation	1	_	
foor - concrete slab on ground, conventional slab.	55.8	not specified			_
external wall: framed (metal clad); frame: timber - untreated softwood.	all external walls	fibreglass batts or roll+ foil/sarking			
internal wall: plasterboard; frame: timber - untreated softwood.	29.1	none			
ceiling and roof - flat ceiling / pitched roof, framed - metal roof, timber - untreated softwood.	106.5	ceiling: fib	reglass batts	or roll; roof: none.	

BASIX	Department of Planning and Environment	www.basix.rsw.gov.au	Version: 4.01 / EUCALYPTUS_03_01_0	Certifica

ment is to be carried out. It is a condition of any development consent granted, or complying	

	Show on DA plans	Show on CC/CDC plans & specs	Certifier check
on throughout 40 square metres of the site.	~	~	
6 but <= 7.5 L/min plus spray force and/or coverage tests) in		~	~
		<b>`</b>	~
6 but <= 7.5 Limin plus spray force and/or coverage tests) in # 4 star in each toilet in the development. on in the development.		> > > > >	~

Version: 4.01 / EUCALYPTUS_03_01_0	Certificate No.: 1740222S	Monday, 18 March 2024	page 3/1

1		Show on DA plans	Show on CC/CDC plans & specs	Certifier check
described in the table below	, in accordance with the specifications	~	~	~
				<u> </u>
-				
		-		
		1		1
	Maximum area - m2			
	10			
	0			
	0			
	0			
	0			
	Maximum area - m2			
	0			
	10			

ying out the development.
ins" column must be shown on the plans accompanying the development application for the proposed development (if a development).
XC plans and specs" column must be shown in the plans and specifications accompanying the application for a construction posed development.
column must be certified by a certifying authority as having been fulfilled, before a final occupation certificate (either interim or

## SIX SUMMARY

nber	Project Number	
	Issue Date	
	Author	
/	Checker	Scale

